NA-0515PRF_CL

NON-ELEV. ALUM. 5 ROW X 15'-0" BLEACHER


DRAWING SHEET INDEX				
CS.1	COVER SHEET			
TD.1	SEATING PLAN			
FP.1	FOUNDATION PLAN			
BA.1	BLEACHER PREP			
BA.2	BRACING LOCATIONS			
BA.3	ASSEMBLY SECTION VIEW			
AP.1	ANCHORING PLAN			
AP.2	ANCHORING PLAN			
PF.1	PLANK & FRAMING PLAN			
GR.1	GUARDRAIL ASSEMBLY			



is the property of NATIONAL RECREATION SYSTEMS, INC. and is not to be reproduced without the express written permission of this manufacturer. We assume no responsibility for unauthorized use of this drawing. NATIONAL RECREATION SYSTEMS, INC. is not responsible for local permits and occupancy requirements.

DESCRIPTION: NON-ELEV. 5 ROW X 15'-0" ASSEMBLY PRINTS

DRAWN BY: JML DATE: 2/13/17 REVISION: (() SCALE: N.T.S. SHEET NUMBER: CS.

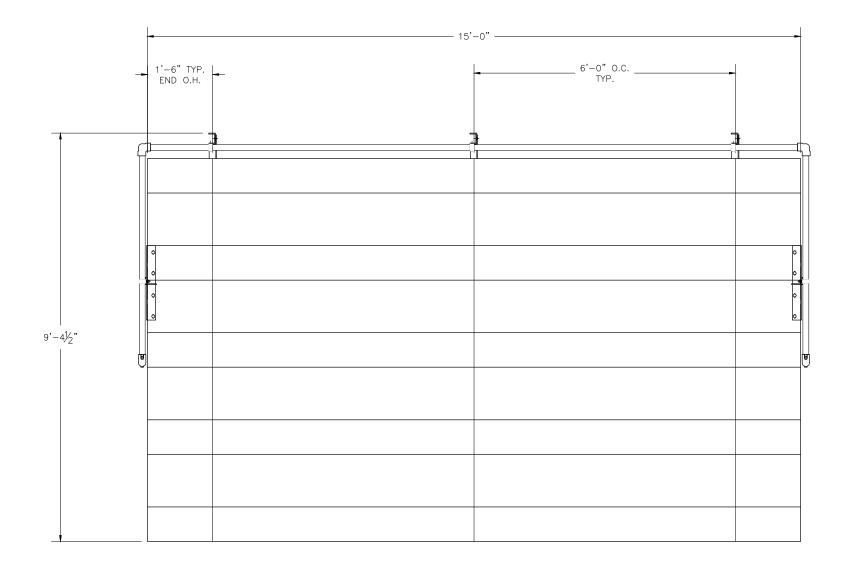

 SECTION
 GROSS
 ACTUAL NO. OF
 NET

 LENGTH
 SEATS
 SEATS
 ROWS
 SEATS

 15
 10.00
 10.00
 5
 50

 NET SEATS
 50

 WHEELCHAIR SPACES
 0

 TOTAL NET SEATING CAPACITY
 50


 (BASED ON 18" PER SEAT)



This drawing and all information contained herein is the property of NATIONAL RECREATION SYSTEMS, INC. and is not to be reproduced without the express written permission of this manufacturer. We assume no responsibility for unauthorized use of this drawing. NATIONAL RECREATION SYSTEMS, INC. is not responsible for local permits and occupancy requirements.

ò,	MODEL NUMBER: NA-0515PRF_CL							
,	DESCRIPTION: NON-ELEV. 5 ROW X 15'-0" SEATING PLAN							
	DRAWN BY: JML	DATE: 2/13/17	REVISION: (())	SCALE: N.T.S.	SHEET NUMBER:	TD.1		

LOCATE FRAMES ON FOUNDATION

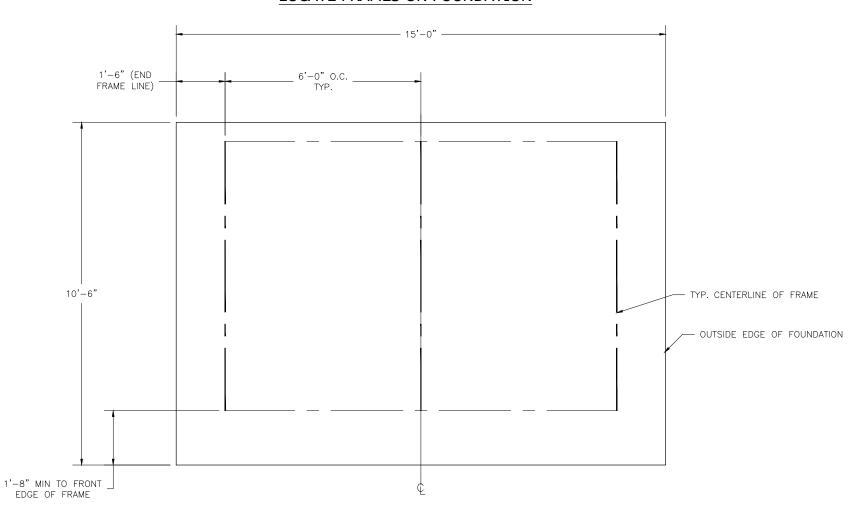

CONCRETE FOUNDATION SPECIFICATIONS

SCOPE

Foundation construction is not part of NATIONAL RECREATION SYSTEMS, INC's., scope of work unless noted otherwise in the contract documents. The OWNER shall review the foundation design with local code authorities and coordinate with NRS, Inc.

FOUNDATION DESIGN & ANCHORS:

- 1) The foundation designs are based on the following:
 - a) Minimum presumed soil bearing of 1000 psf.
 - b) Bleacher frame dead and live load of 700 lbs./ft.
 - c) Bleacher frame wind uplift of 250 lbs./ft.
- 2) Unless otherwise specified on the drawings the bleacher frames shall be attached to concrete with a ½" dia. x 3" wedge type expansion anchor. The anchors shall be embedded a minimum of 2" into the concrete.

CONCRETE SPECIFICATIONS:

- 1) All concrete construction shall be in accordance with ACI 318.08.
- 2) All concrete shall be air-entrained using an air entraining admixtruing meeting ASTM C620. Total air content: 5%-7% per ASTM C173.
- 3) All concrete shall have a minimum 28-day strength of Fc=3000psi. Concrete shall have air-entrainment
- 4) A ¼" bituminous expansion joint material shall be placed between strip and slab foundations when adjacent to each other.
- 5) The depressions in the top of the foundations between high spots shall not exceed \(\frac{5}{6} \) below 10-foot long straightedge. The 10-foot straightedge method used to measure foundation flatness shall be in accordance with \(ACI \) 302.1R-04 "Guide for Concrete Floor and Slab \(Construction" \).

CONCRETE SLAB RECOMMENDED SPECIFICATIONS:

- 1) Concrete slab shall have a minimum thickness of 5" (some areas may require 6") and placed on 4" of compacted gravel or compacted sub base.
- NRS. INC., recommends that the concrete slab be reinforced with 6x6-W2.1xW2.1 welded wire fabric at 1½" concrete cover from the top. In lieu of welded wire fabric, steel fiber substitution requires OWNER approval and his understanding of potential maintenance issues.
- 3) Contractor may substitute blended fiber reinforcing, provided the blend consists of multifilament polypropylene fibers and cold drawn steel wire fibers. Novamesh 950 or approved equivalent, applied at a dosage rate of 5lb/CY unless specified otherwise or a different recommendation is made by the manufacturer.
- 4) Crack control joints shall be sawed into slab to form approximate square patterns. The maximum spacing for control joints shall not exceed 12'-6", UNLESS INDICATED OTHERWISE. The bleacher frames shall not be set on control joints. The designer shall contact NRS to coordinate joint spacing requirements with the specific bleacher design.
- 5) The slab may be sloped a maximum of 1/8 inch per foot for drainage. The maximum overall out of level slope for the slab perpendicular to the seats (front to rear) shall not exceed 2" and parallel to the seats (end to end) shall not exceed 4".




1300-D AIRPORT NORTH OFFICE PARK FORT WAYNE, IN 46825 PH: 888-568-9064 FAX: 260-482-7449 WWW.BLEACHERS.NET

This drawing and all information contained herein is the property of NATIONAL RECREATION SYSTEMS, INC. and is not to be reproduced without the express written permission of this manufacturer. We assume no responsibility for unauthorized use of this drawing. NATIONAL RECREATION SYSTEMS, INC. is not responsible for local permits and occupancy requirements.


MODEL NUMBER: NA — 0515PRF_CL

DESCRIPTION: NON—ELEV. 5 RO

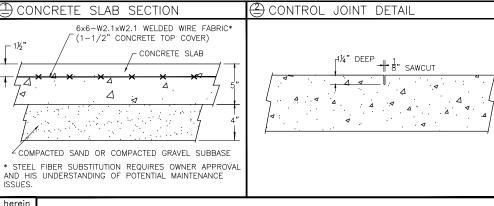

DESCRIPTION: NON-ELEV. 5 ROW X 15'-0" FOUNDATION PLAN

DRAWN BY: JML DATE: 2/13/17 REVISION: (0) SCALE: N.T.S. SHEET NUMBER: FP.

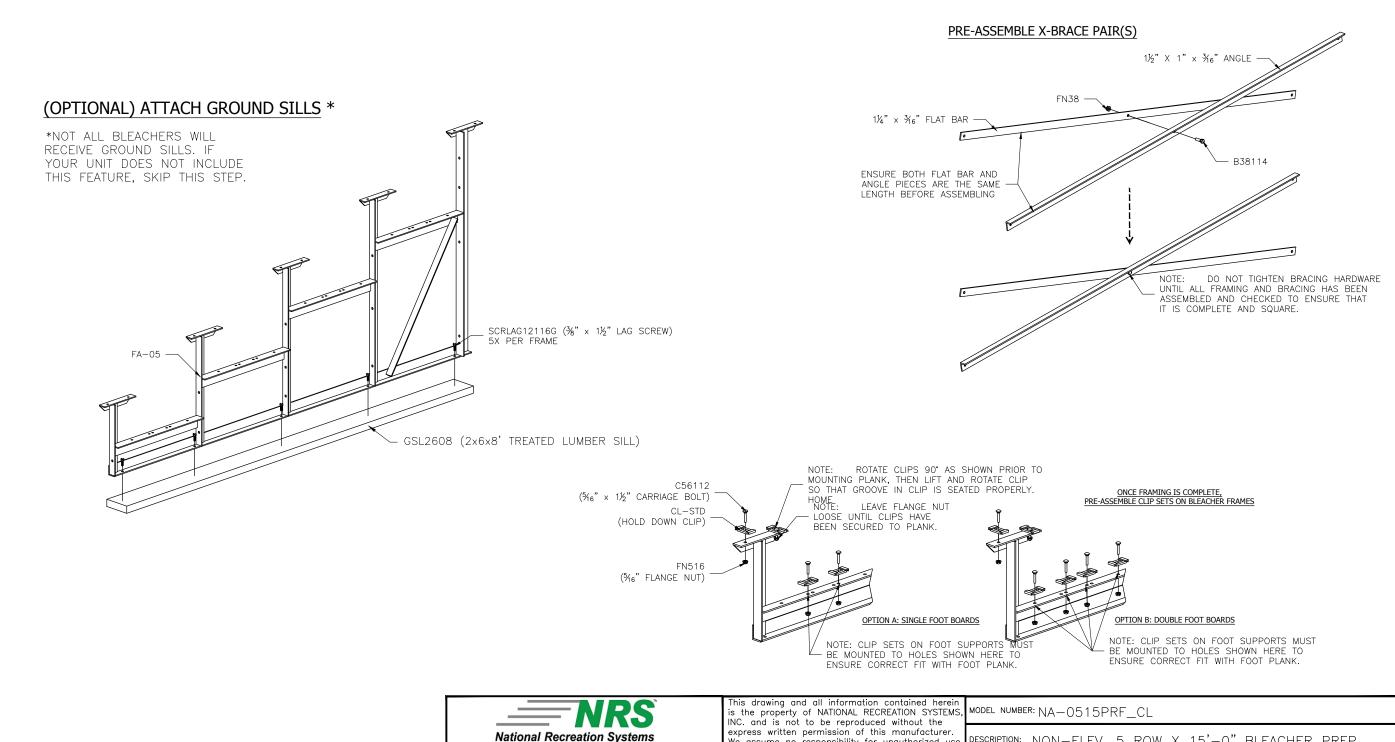

We assume no responsibility for unauthorized use

of this drawing. NATIONAL RECREATION SYSTEMS,

INC. is not responsible for local permits and

occupancy requirements.

DESCRIPTION: NON-ELEV. 5 ROW X 15'-0" BLEACHER PREP

REVISION: (())

SCALE: N.T.S. SHEET NUMBER: BA.


DATE: 2/13/17


DRAWN BY: JML


National Recreation Systems

1300-D AIRPORT NORTH OFFICE PARK FORT WAYNE, IN 46825 PH: 888-568-9064 FAX: 260-482-7449 WWW.BLEACHERS.NET

A PLAYCORE Company

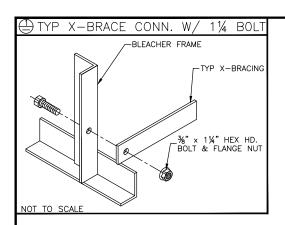

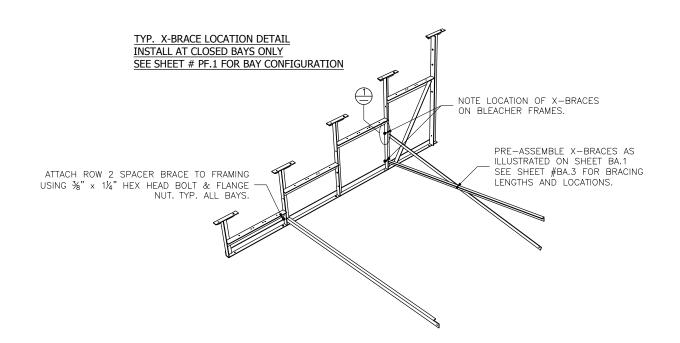

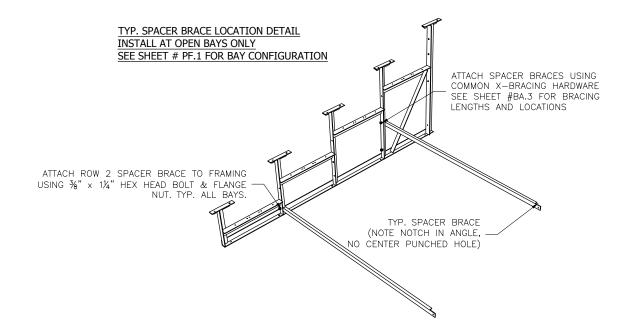





1300-D AIRPORT NORTH OFFICE PARK FORT WAYNE, IN 46825 PH: 888-568-9064 FAX: 260-482-7449 WWW.BLEACHERS.NET

This drawing and all information contained herein is the property of NATIONAL RECREATION SYSTEMS, INC. and is not to be reproduced without the express written permission of this manufacturer. We assume no responsibility for unauthorized use of this drawing. NATIONAL RECREATION SYSTEMS, INC. is not responsible for local permits and occupancy requirements.


DESCRIPTION: NON-ELEV. 5 ROW X 15'-0" BRACING LOCATIONS

DRAWN BY: JML DATE: 2/13/17REVISION: () SCALE: N.T.S. SHEET NUMBER: BA.2

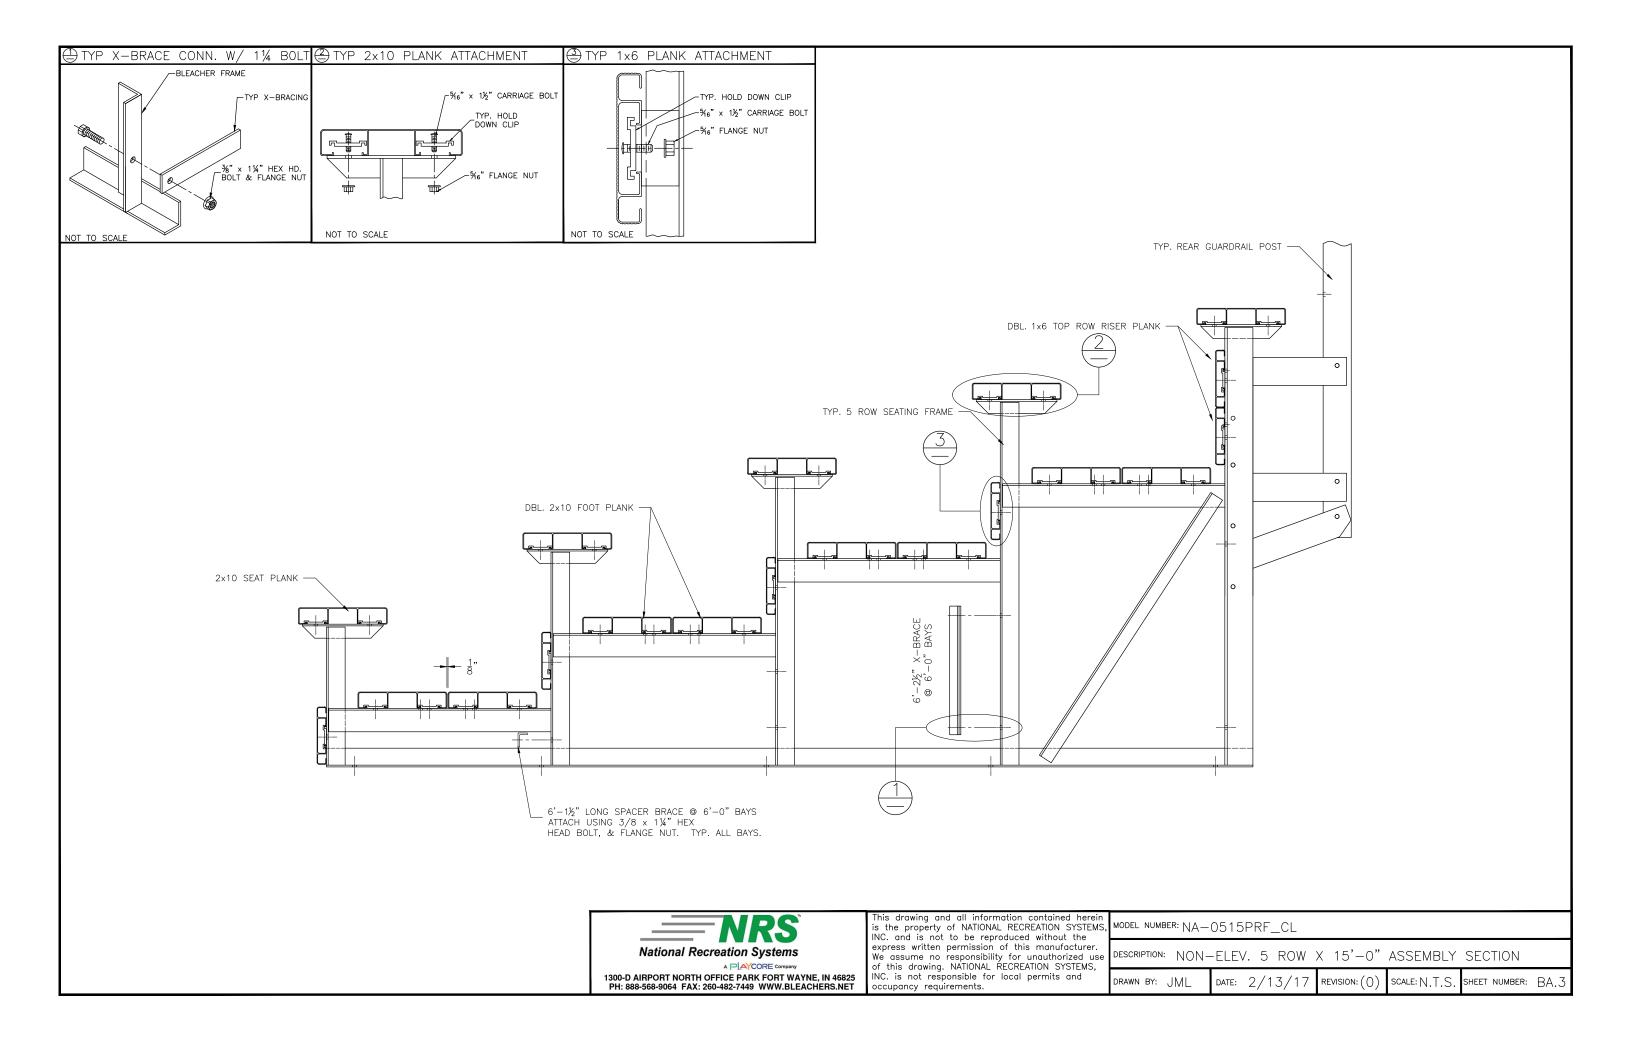

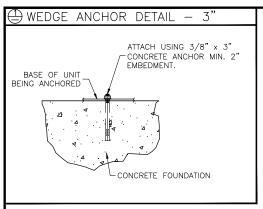

(OPTIONAL) ANCHOR BLEACHER TO CONCRETE FOUNDATION *

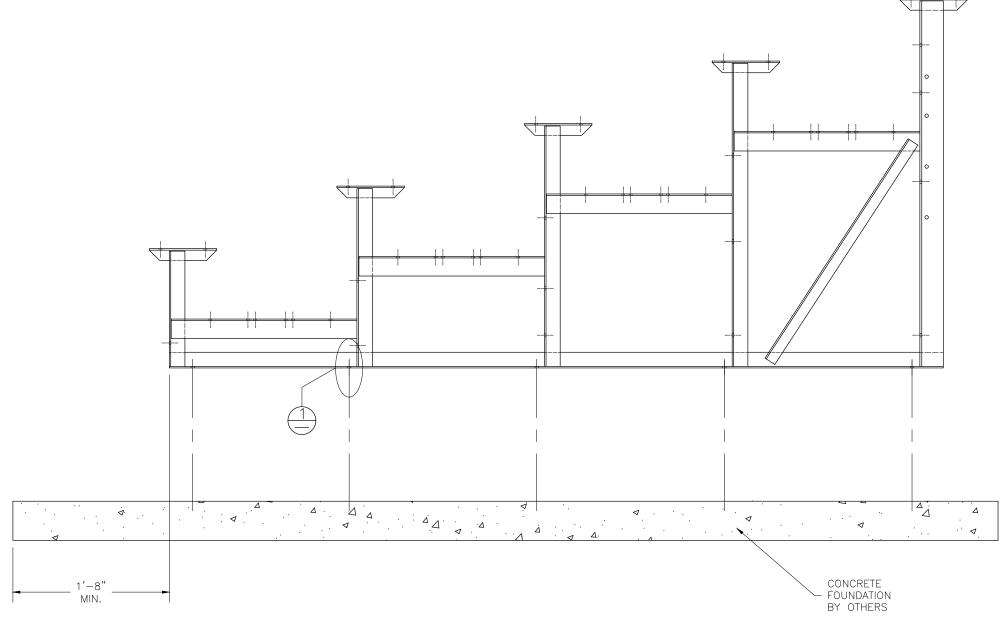




This drawing and all information contained herein is the property of NATIONAL RECREATION SYSTEMS, INC. and is not to be reproduced without the express written permission of this manufacturer. We assume no responsibility for unauthorized use of this drawing. NATIONAL RECREATION SYSTEMS, INC. is not responsible for local permits and occupancy requirements.


DESCRIPTION: NON-ELEV. 5 ROW X 15'-0" ANCHORING PLAN


SCALE: N.T.S. SHEET NUMBER: AP. DRAWN BY: JML DATE: 2/13/17REVISION: (()


DETAIL 'A' - STRAP HEAD DETAIL

DETAIL 'B' - GROUND SILL ATTACHMENT

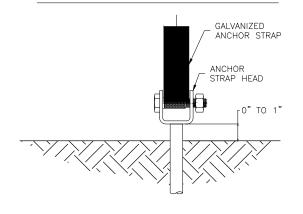

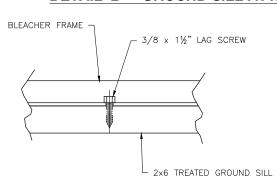

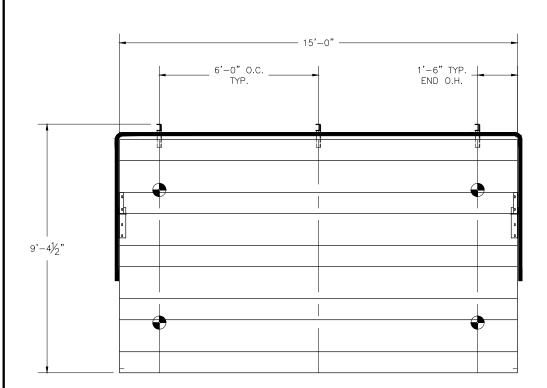

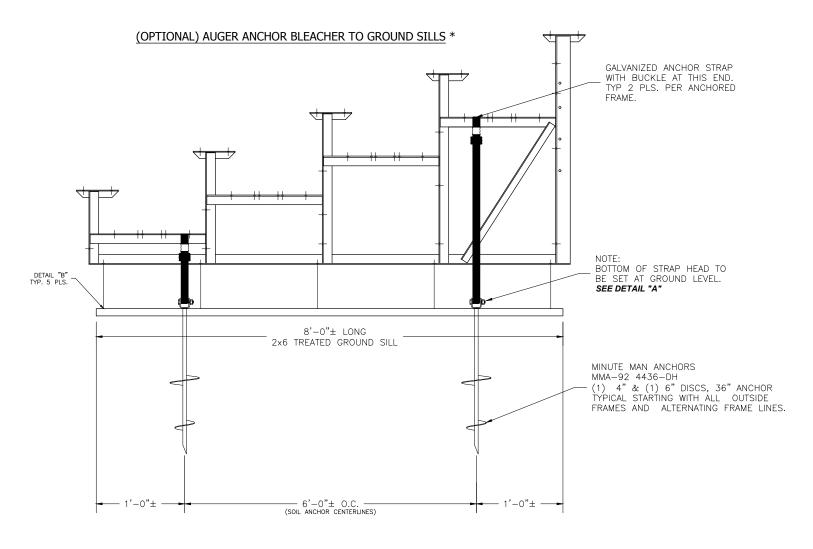




- INDICATES LOCATIONS OF GROUND AUGERS




This drawing and all information contained hereir is the property of NATIONAL RECREATION SYSTEMS, MODEL NUMBER: NA-0515PRF_CL INC. and is not to be reproduced without the express written permission of this manufacturer. We assume no responsibility for unauthorized use of this drawing. NATIONAL RECREATION SYSTEMS, INC. is not responsible for local permits and occupancy requirements.

DESCRIPTION: NON-ELEV. 5 ROW X 15'-0" ANCHORING PLAN

DRAWN BY: JML DATE: 2/13/17REVISION: (() SCALE: N.T.S. SHEET NUMBER: AP.2

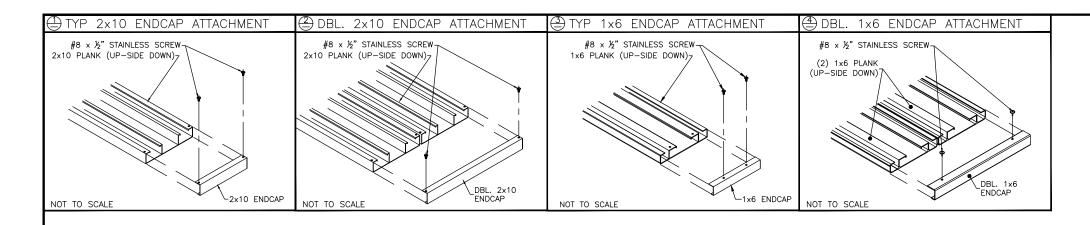

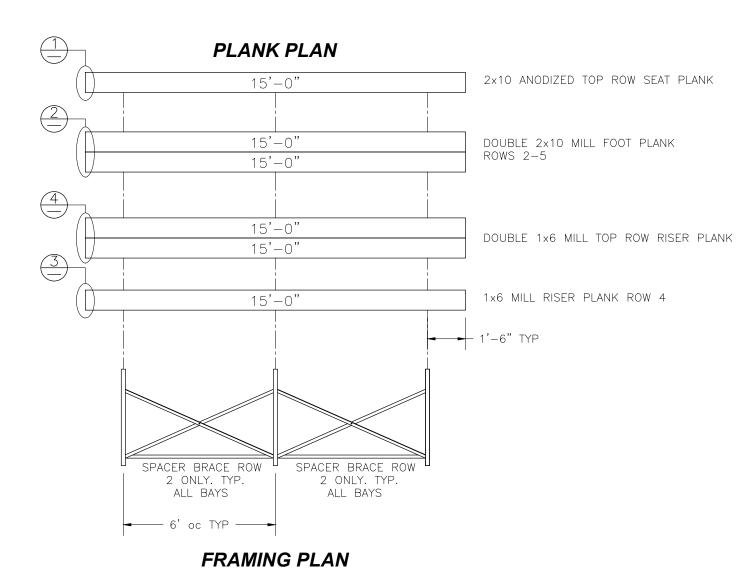



This drawing and all information contained herein is the property of NATIONAL RECREATION SYSTEMS, INC. and is not to be reproduced without the express written permission of this manufacturer. We assume no responsibility for unauthorized use of this drawing. NATIONAL RECREATION SYSTEMS, INC. is not responsible for local permits and occupancy requirements.

DESCRIPTION: NON-ELEV. 5 ROW X 15'-0" PLANK & FRAMING PLAN

DRAWN BY: JML DATE: 2/13/17REVISION: (() SCALE: N.T.S. SHEET NUMBER: PF.

